SDA ASSESSMENT REVISION_A _07.06.2024 ARCHITECTURAL DRAWINGS

A000	COVER SHEET	Α
A001	SURVEY PLAN	Α
A002	DEMOLITION PLAN	А
A003	SITING PLAN	А
A100	NDIS PLAN	А
A101	ROOF PLAN	А
A300	EXTERNAL ELEVATIONS 01	А
A301	EXTERNAL ELEVATIONS 02	А
A401	INTERNAL ELEVATIONS - KITCHEN + L'DRY	А
A402	INTERNAL ELEVATIONS - ENS + BATH	Α
A500	TYPICAL DETAILS	Α
A600	GENERAL NOTES	Α

240501 - -9 FRONSAC AVENUE CORIO VIC 3214

COMMUNITY CARE ACCOMMODATION



SUBJECT SITE

NEARBY AMENITIES

1. CORIO VILLAGE - 750m

2. BELLPOST SHOPPING CENTRE - 3.8km

3.GEELONG GATE HOMEMAKER CENTRE - 2.9km

- TRANSPORT

 1. CORIO TRAIN STATION 2.9km
 2. NORTH SHORE TRAIN STATION 3.2km
- 3. BUS SERVICES
- HARPUR RD/ BACCHUS MARSH RD 350m

- EDUCATION

 1. NORTHERN BAY COLLEGE 550m

 2. ST.FRANCIS XAVIER SCHOOL 1.4km
- 3. ST.THOMAS PRIMARY SCHOOL 1.7km 4. CORIO KINDERGARTEN - 1.4km
- 5. MONTESSORI MINDS CHILDCARE 2.4km

<u>HEALTH</u>

- 1. CORIO COMMUNITY HEALTH CENTRE 700m 2. FIRST POINT MEDICAL CENTRE 1.1km
- 3. CORIO MEDICAL CLINIC 800m
- 4. GEELONG HEALTHCARE 2.3km

- OPEN SPACE 1. DETROIT RESERVE 600m
- 2. STEAD PARK PLAYGROUND 1.2km
- 3. GOLDSWORTHY RESERVE 1.0km
- 4. CORIO COMMUNITY PARK 900m

FOR CONSTRUCTION

Description SDA ASSESSMENT

07.06.2024 YOUNUS KHAN & SOBIA YOUNUS

9 FRONSAC AVENUE CORIO VIC 3214


SURVEY PLAN



Orawing No.	Issue
A001	AA
Scale	Drawing Size
1 : 250	A3
Project No.	Drawn
240501 -	^B y's

Dimensioned drawings to take precedence over scaling. Contractor to verify all dimensions on site before construction. All inconsistencies to be reported to the Architect immediately.

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FOR CONSTRUCTION

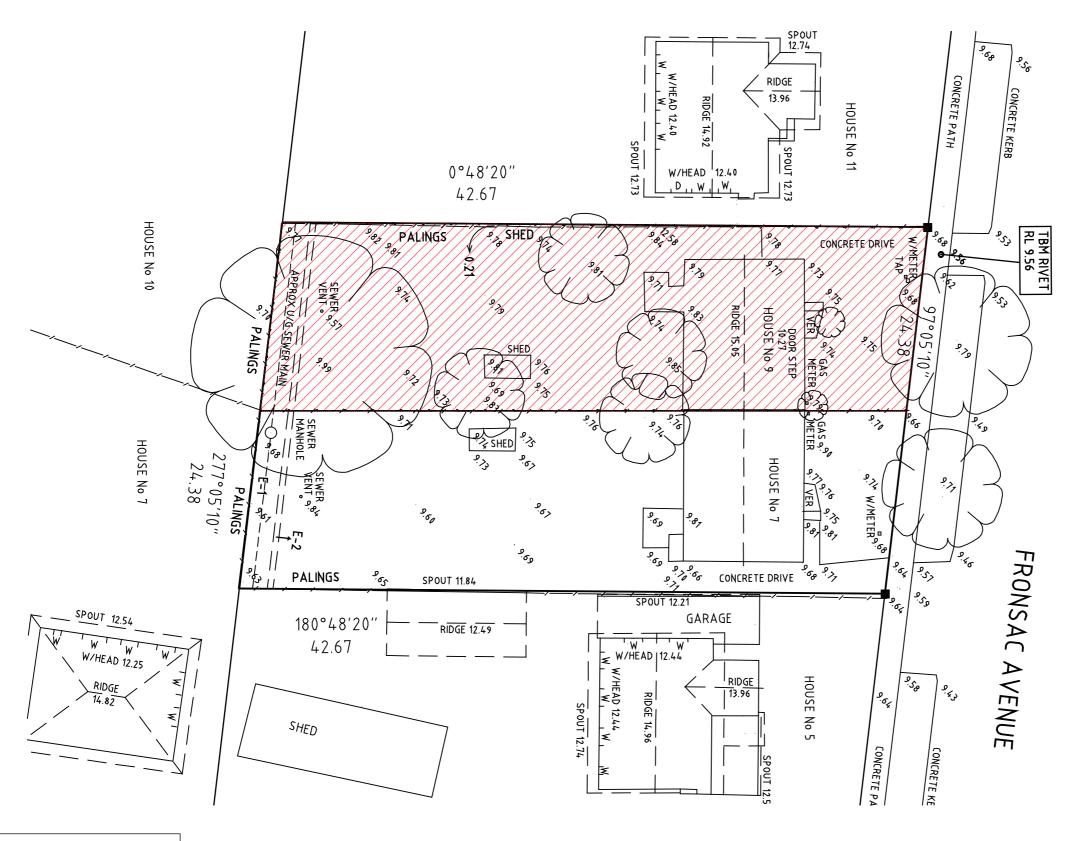NOTE: ALL EXISTING BUILDINGS, DRIVEWAYS AND VEGETATION WITHIN THE TITLE BOUNDARY TO BE DEMOLISHED. FRONT FENCE TO BE DEMOLISHED, WITH SIDE AND REAR BOUNDARY FENCING TO BE RETAINED.

Description Date Client
SDA ASSESSMENT 07.06.2024

9 FRONSAC AVENUE CORIO VIC 3214


DEMOLITION PLAN



Issue
AA
Drawing Size
A3
Drawn
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Dimensioned drawings to take precedence over scaling. Contractor to verify all dimensions on site before construction. All inconsistencies to be reported to the Architect immediately.



PROJECT INFORMATION

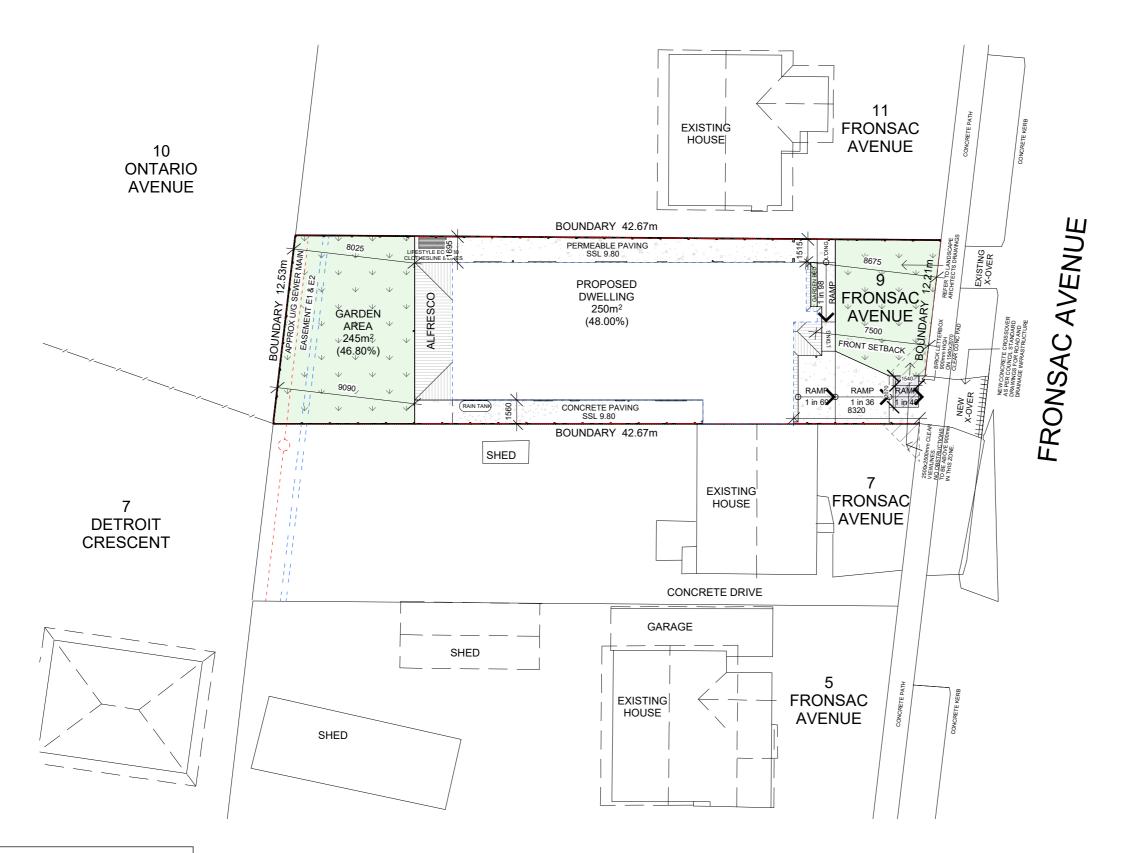ADDRESS: 9 FRONSAC AVENUE CORIO VIC 3214

LOCAL GOVERNMENT:

CITY OF GREATER GEELONG

SITE AREA: 523m²

DWELLING AREA: INTERNAL: 200.00m² GARAGE: 25.00m² PORCH: 3.00m² ALFRESCO: 22.00m²

SITE COVERAGE: (LESS THAN 60%)

250.00m² - 48.00%

PERMEABILITY: (MORE THAN 20%)

160.00m² - 30.60%

GARDEN AREA: (MORE THAN 35%)

245.00m² - 46.80%

FOR CONSTRUCTION

Issue Description
A A SDA ASSESSMENT

07.06.2024


9 FRONSAC AVENUE CORIO VIC 3214 SITING PLAN



Drawing No.	Issue
A003	AA
Scale	Drawing Size
1:250	A3
Project No.	Drawn
240501 -	B∤S
CAD	

Dimensioned drawings to take precedence over scaling. Contractor to verify all dimensions on site before construction. All inconsistencies to be reported to the Architect immediately.

CAD Reference 8/06/2024 6:52:13 PM

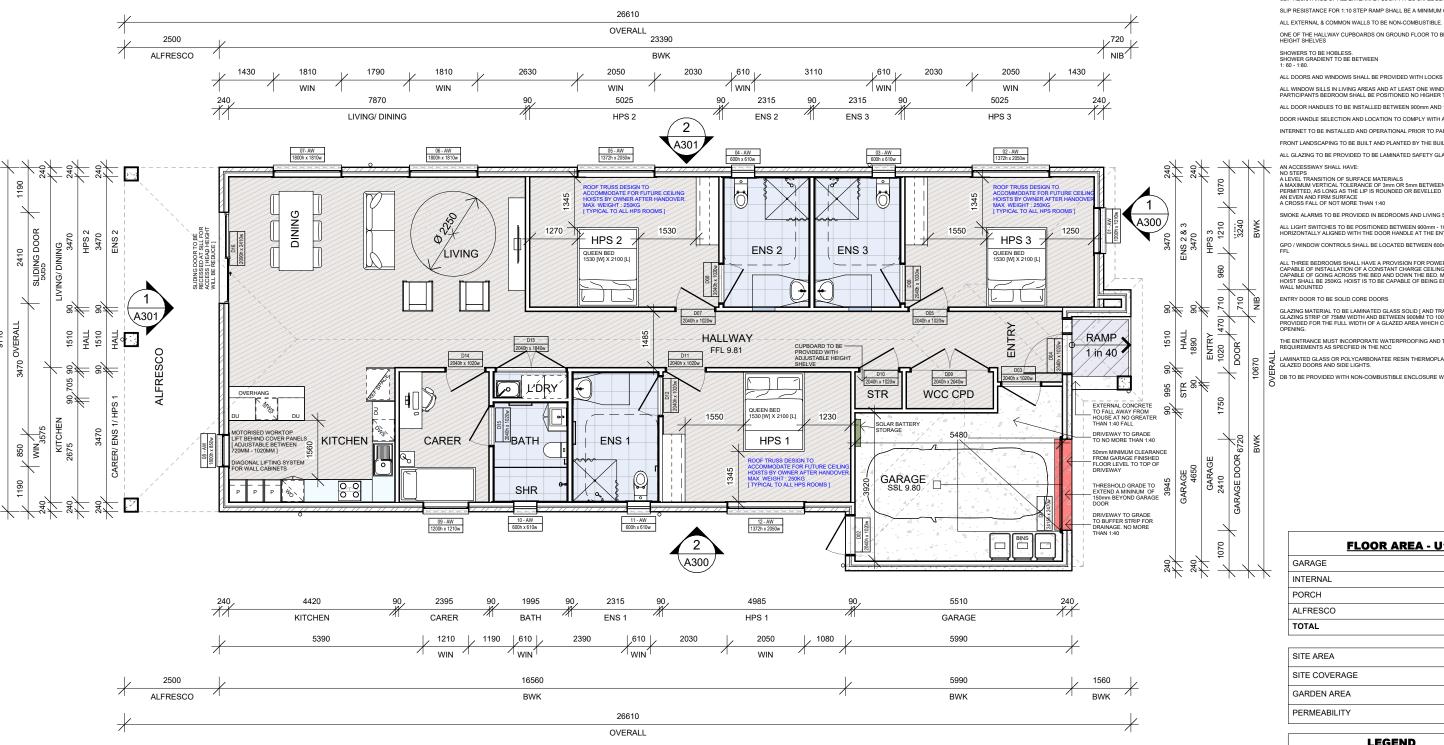

SLIP RESISTANCE OF ALL INTERNAL FLOOR TYPES SHALL BE A MINIMUM OF P3 OR R10 SLIP RESISTANCE OF ALL EXTERNAL FLOOR TYPES SHALL BE A MINIMUM OF P4 OR R11

SLIP RESISTANCE FOR 1:10 STEP RAMP SHALL BE A MINIMUM OF P5 OR R12

ALL EXTERNAL & COMMON WALLS TO BE NON-COMBUSTIBLE.

ALL WINDOW SILLS IN LIVING AREAS AND AT LEAST ONE WINDOW SILL IN EACH PARTICIPANTS BEDROOM SHALL BE POSITIONED NO HIGHER THAN 1000mm AB

ALL DOOR HANDLES TO BE INSTALLED BETWEEN 900mm AND 1100mm ABOVE THE FFL

DOOR HANDLE SELECTION AND LOCATION TO COMPLY WITH AS1428.1

SMOKE ALARMS TO BE PROVIDED IN BEDROOMS AND LIVING SPACES

GPO / WINDOW CONTROLS SHALL BE LOCATED BETWEEN 600mm AND 1100mm ABOVE THE

DB TO BE PROVIDED WITH NON-COMBUSTIBLE ENCLOSURE WITH SMOKE SEALS

	FLOOR AREA - U1	
GARAGE		25.00m ²
INTERNAL		200.00m ²
PORCH		3.00m ²
ALFRESCO		22.00m ²
TOTAL		250.00m ²

SITE AREA	523m ²
SITE COVERAGE	48%
GARDEN AREA	46.80%
PERMEABILITY	30.60%

LEGEND					
FLOOR FINISHES	WINDOW				
LAM. TIMBER FLOORING	SW = SLIDING WINDOW AW = AWNING WINDOW				
TILES FLOORING	FW = FIXED WINDOW				
FLOORING	SD = SLIDING DOOR				
CONCRETE PAVING	OG = OBSCURE GLASS				

FOR CONSTRUCTION

Description SDA ASSESSMENT

07.06.2024

9 FRONSAC AVENUE CORIO VIC 3214


NDIS PLAN



Drawing No.	Issue
A100	AA
Scale	Drawing Size
1:100	A3
Project No.	Drawn
240501 -	₽¥S
CAD	

Dimensioned drawings to take precedence over scaling. Contractor to verify all dimensions on site before construction. All inconsistencies to be reported to the Architect immediately.

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NOTES:

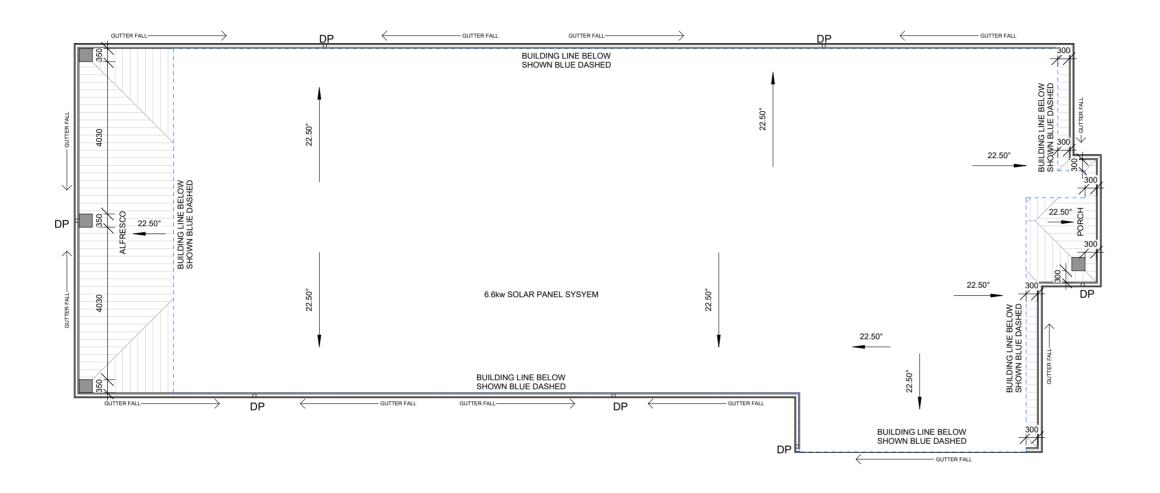- EMERGENCY POWER SOLUTIONS SHALL
 BE PROVIDED TO CATER FOR A MINIMUM 2HOUR OUTAGE IN NO LESS THAN 2 DOUBLE
 GPOS IN PARTICIPANT BEDROOMS AND
 ANY PROVIDED AUTOMATED DOORS THAT
 ARE USED FOR ENTRY OR EGRESS.
 INTERNET CONNECTION SHALL BE
 PROVIDED WITH THE ABILITY FOR HIGH
 INTERNET SPEEDS TO BE MAINTAINED AND
 STABLE IN NATURE WITH WI-FI COVERAGE
 THROUGHOUT ALL AREAS OF THE
 DWELLING.
- A VIDEO, INTERCOM OR OTHER COMMUNICATION SYSTEM SHALL BE PROVIDED TO ENABLE COMMUNICATION BETWEEN THE PARTICIPANT AND THEIR SUPPORTS WHEN NOT WITHIN LINE OF SIGHT.
- REVERSE CYCLE AIR-CONDITIONING SHALL BE PROVIDED TO LIVING AREAS AND BEDROOMS WITH CONTROL PANELS IN AN ACCESSIBLE LOCATION BETWEEN 900MM AND 1100MM FROM FFL AND NOT CLOSER THAN 500MM TO ANY INTERNAL CORNER.

THE FOLLOWING GPOS SHALL BE PROVIDED:

- THREE DOUBLE GPO ON THE WALL WHERE THE HEAD OF THE BED IS LIKELY TO BE, AND
- AT LÉAST ONE DOUBLE GPO ON THE WALL OPPOSITE THE WALL WHERE THE HEAD OF THE BED IS LIKELY TO BE.
- POWER AND CONTROL CABLING TO WINDOWS OF BEDROOMS AND LIVING AREAS SHALL BE PROVIDED FOR FUTURE WINDOW BLIND AUTOMATION. A CAPPED GPO AT THE WINDOW HEAD MAY BE PROVIDED TO COMPLY WITH THIS REQUIREMENT.
- POWER AND CONTROL CABLING TO HEAD OF ENTRY DOORS OF PARTICIPANT BEDROOMS, ONE EXTERNAL ENTRY DOORWAY AND ONE EXTERNAL DOORWAY TO AN OPEN AREA (WHERE PROVIDED) SHALL BE PROVIDED FOR FUTURE AUTOMATION.

 A CAPPED GPO AT THE DOOR HEAD MAY BE PROVIDED TO COMPLY WITH THIS REQUIREMENT.

FOR CONSTRUCTION

Issue Description
A A SDA ASSESSMENT

07.06.2024

9 FRONSAC AVENUE CORIO VIC 3214

ROOF PLAN



Drawing No.	Issue
A101	AA
Scale	Drawing Size
1:100	A3
Project No.	Drawn
240501 -	₽¥S
AD	

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Dimensioned drawings to take precedence over scaling. Contractor to verify all dimensions on site before construction. All inconsistencies to be reported to the Architect immediately.

CAD

Reference

WINDOW & DOOR DIMENSIONS
ALL WINDOW & DOOR DIMENSIONS TO REFER WINDOW & DOOR SCHEDULES.

WINDOW CONFIGURATION
ALL WINDOWS TO HAVE A HEAD HEIGHT OF
2143mm ABOVE FFL.

INFILL MATERIALS OVER ALL DOORS & WINDOWS TO MATCH ADJACENT WALL

ARTICULATION JOINTS

VERTICAL ARTICULATION JOINT LOCATIONS
SHOWN ARE A GUIDE ONLY. LOCATIONS MAY BE ALTERED ON SITE AS DETERMINED BY BRICK LAYER - TO COMPLY WITH N.C.C. 3.3.5.13 AND AS


METAL ROOF @22.5° PITCH TIMBER TRUSSES AS PER MANUFS. SPEC

NO EAVES FROM BRICK WORK [EXCLUDING THE FACADE]
300mm EAVES FROM BRICKWORK WHERE SHOWN.

DOWNPIPES TO BE PROVIDED @ 1 PER 60M2 AND/OR EVERY 12m IN DISTANCE .EXCLUDING BOX GUTTERS & RAINHEADS

SOLAR PANEL LOCATION TO COMPLY WITH MANUFACTURERS REQUIREMENTS ANDS AS/NZ 3500 PLUMBING & DRAINAGE.

NO LIGHTWEIGHT INFILL MATERIAL OVER WINDOWS & DOORS TO BE VISABLE FROM ANY ROAD OR PUBLIC RESERVE.

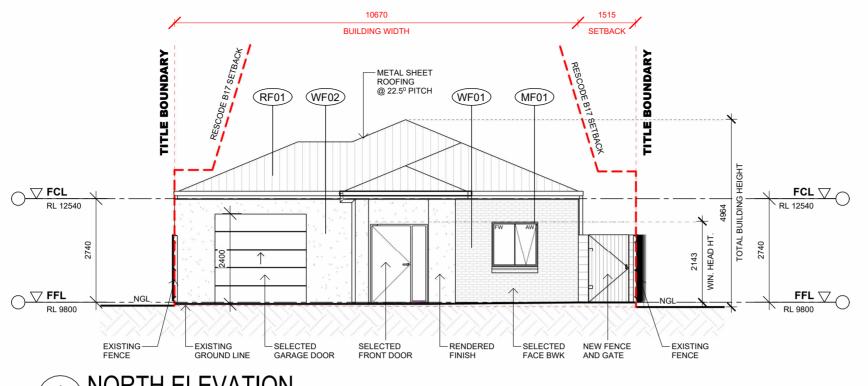

MATERIALS SCHEDULE



WF01 PGH 'PUTTY' BRICKS FINISH OR SIMILAR



WF02 DULUX 'BEIGE ROYAL' RENDER FNISH OR SIMILAR



GL01 CLEAR GLAZING




RF01 COLORBOND ROOF SHEETING DUNE' OR SIMILAR



MF01 ALUMINIUM FINISH COLORBOND



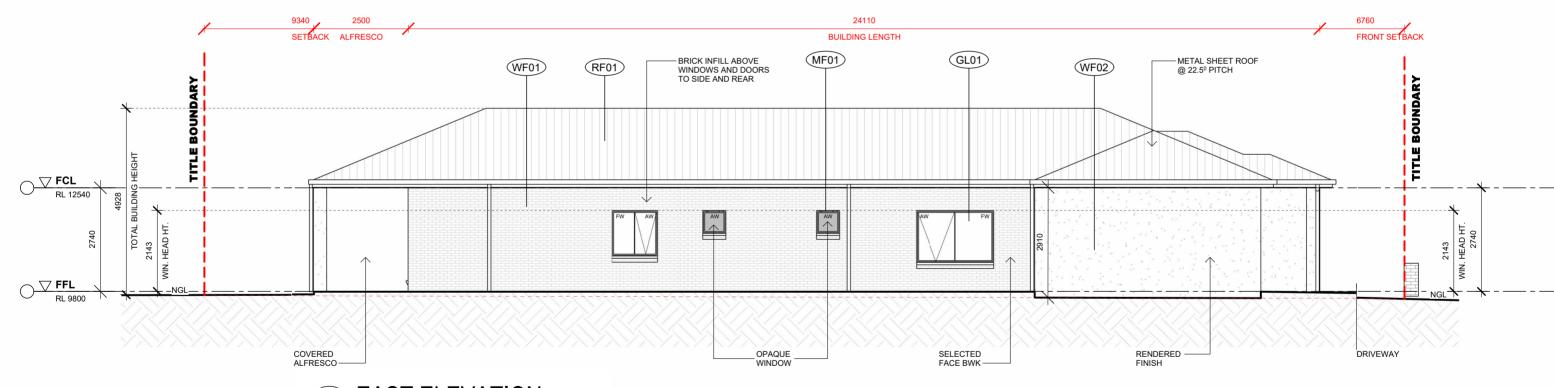

FOR CONSTRUCTION


АА

EAST ELEVATION A100 / SCALE 1:100


•	Description	Date	Client
	SDA ASSESSMENT	07.06.2024	YOUNUS KHAN & SOBIA YOUNUS

9 FRC	NSAC A	AVENUE			EXTERNAL ELEVATIONS 01	A300	AA
CORIO	O VIC 32	214				Scale As indicated	Drawing Size
						Project No. 240501 -	Drawn B Y S
0	1	2	3	4m 1:100	Dimensioned drawings to take precedence over scaling. Contractor to verify all dimensions on site before construction. All inconsistencies to be reported to the Architect immediately.	CAD Reference	

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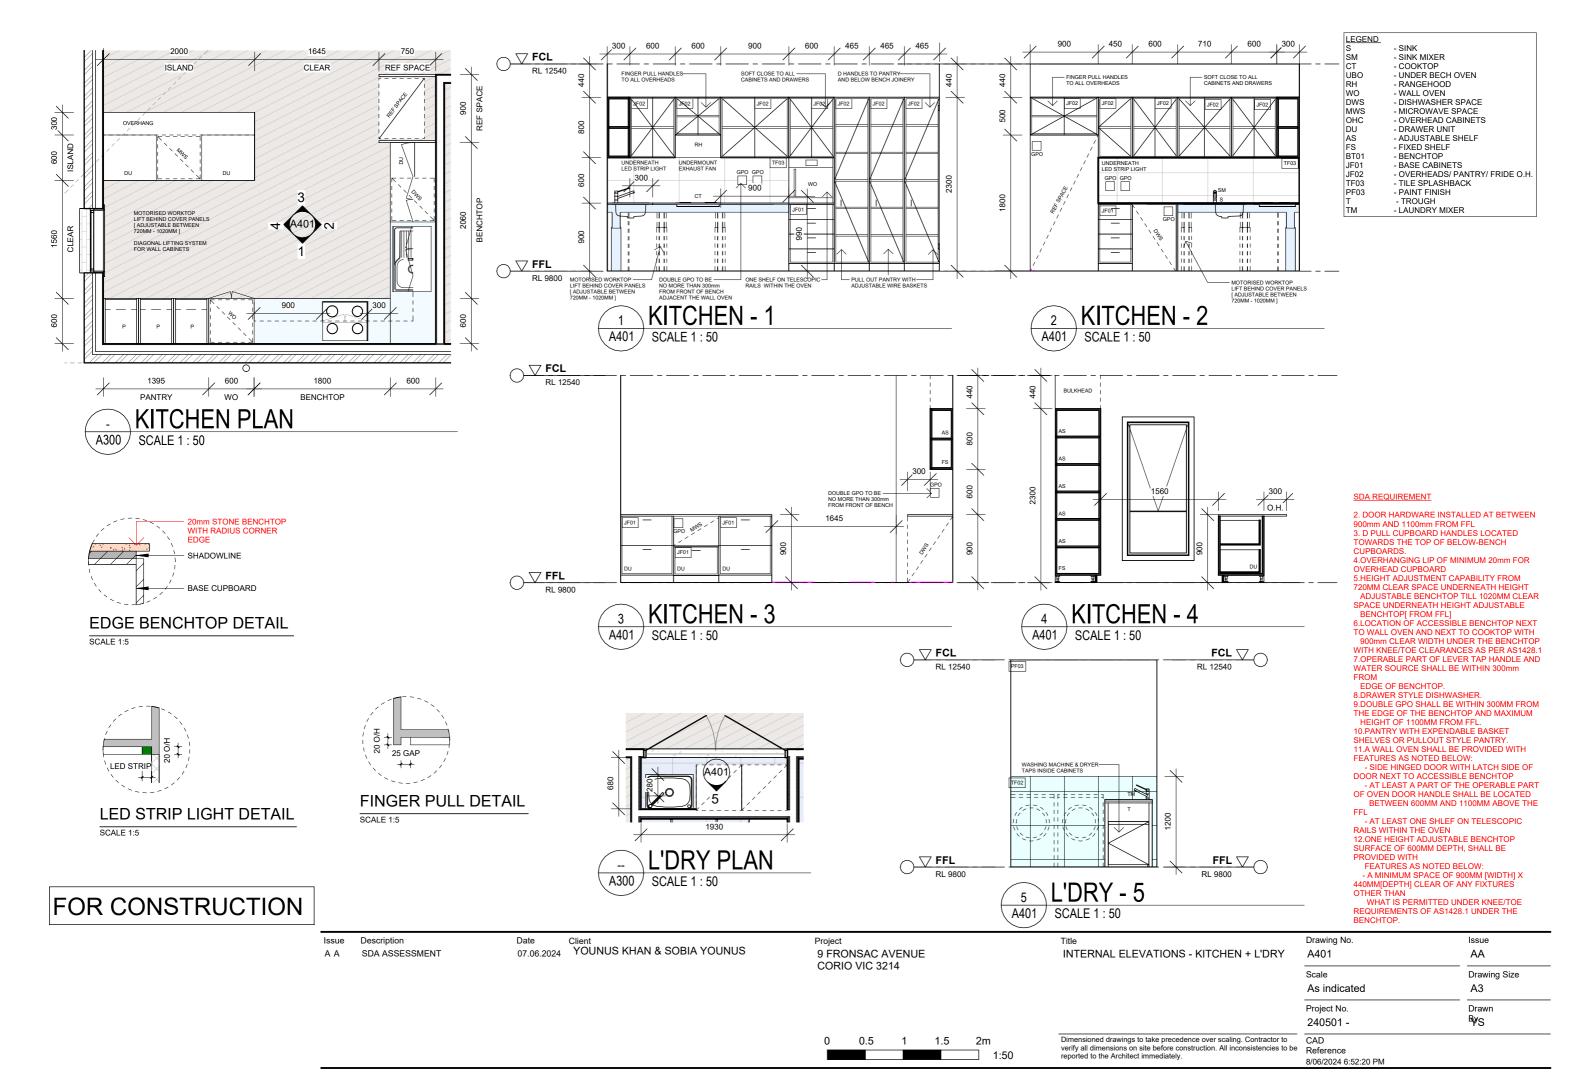


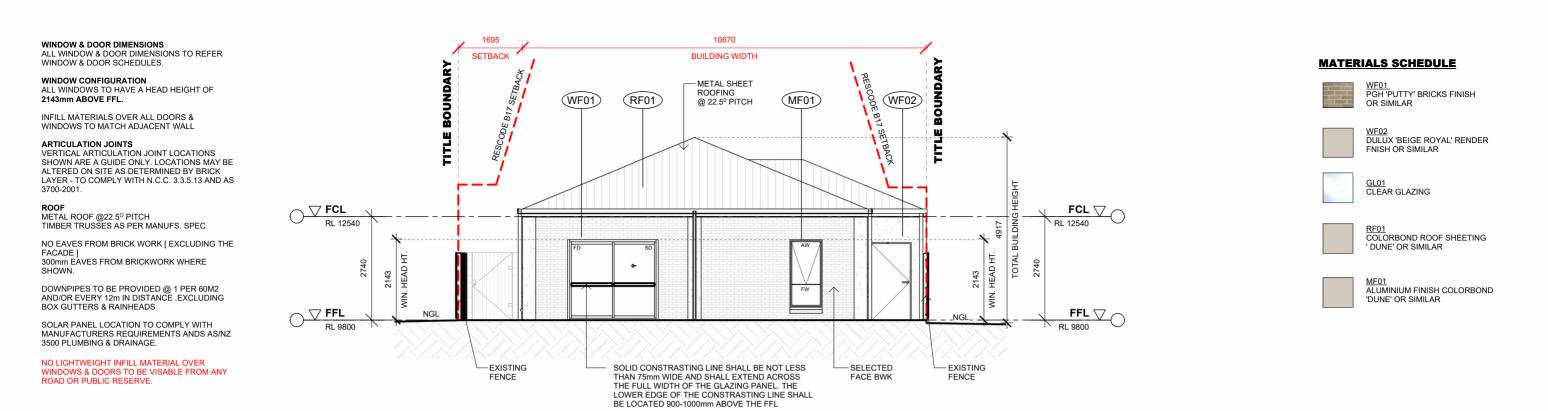
SOUTH ELEVATION

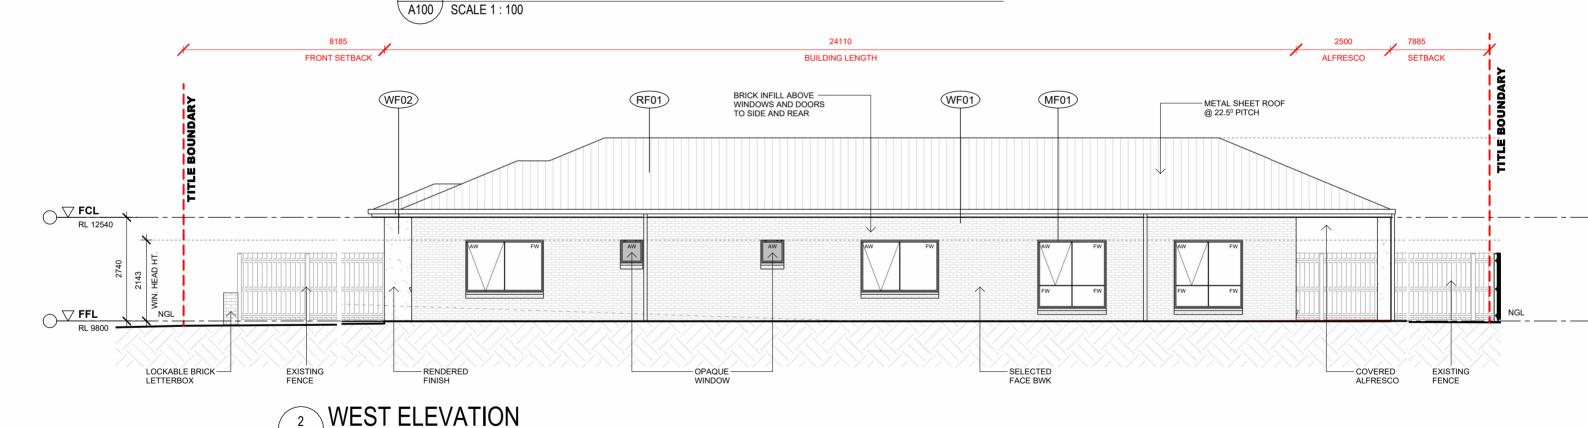


FOR CONSTRUCTION

Issue A A	Description SDA ASSESSMENT	Date Client 07.06.2024	Project 9 FRONSAC AVENUE	Title EXTERNAL ELEVATIONS 02	Drawing No. A301	Issue AA
			CORIO VIC 3214		Scale As indicated	Drawing Size
					Project No. 240501 -	Drawn ^R YS
			0 1 2 3 4m 1:100	Dimensioned drawings to take precedence over scaling. Contractor verify all dimensions on site before construction. All inconsistencies reported to the Architect immediately.	to CAD to be Reference 8/06/2024 6:52:19 PM	



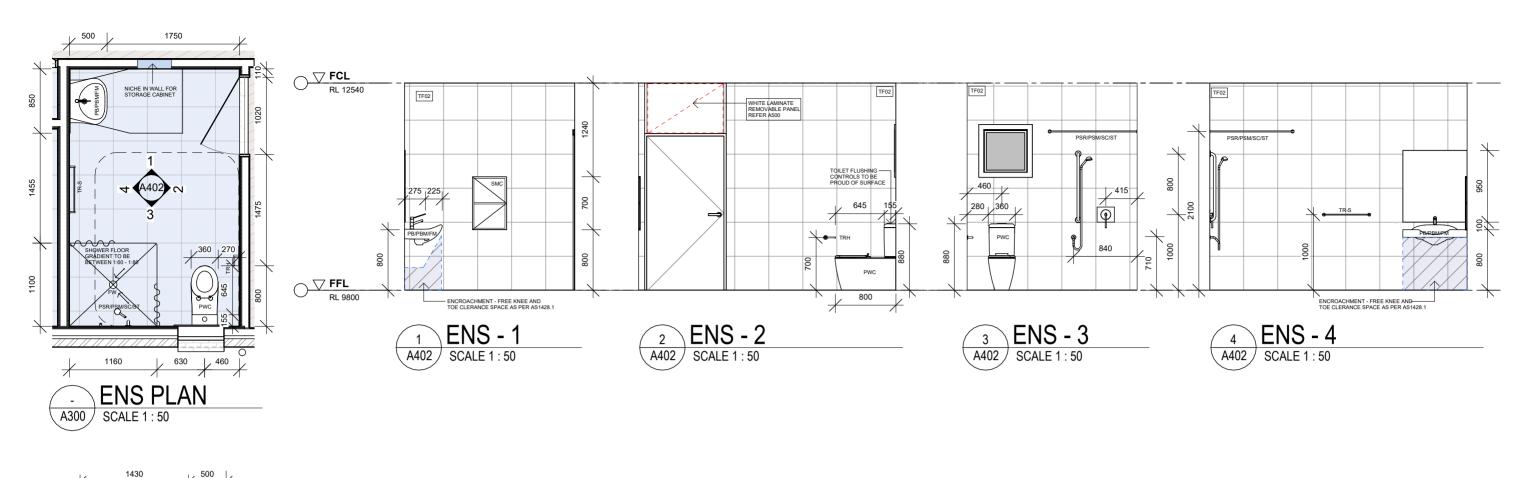

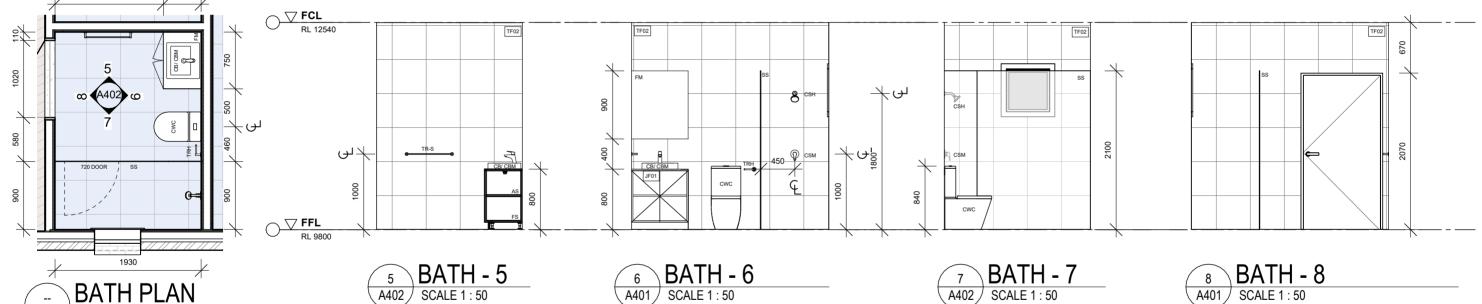

DOOR HARDWARE INSTALLED AT BETWEEN 900mm AND 1100mm FROM FFL.

SHOWER REQUIREMENT
ONLY VERTICAL GRABRAIL SHALL BE PROVIDED WITH HEIGHT ADJUSTABLE SHOWER HEAD AND HOSE AS PER AS1428.1
TAPS SHALL BE LOCATED IN A ZONE BETWEEN 900mm AND 1100mm ABOVE FFL AND AT A MINIMUM OF 300MM AND MAXIMUM OF 800mm FROM INTERNAL CORNER.
ANY TYPE OF FLOOR DRAIN INCLUDING STRIP DRAIN IS PERMITTED TO ADEQUATELY DRAIN THE SHOWER FLOOR.

FOR CONSTRUCTION

A300

SCALE 1:50

WC REQUIREMENT
WC PAN SHALL BE AS1428.1 COMPLIANT [AS PER REQUIREMENTS FOR ACCESSIBLE UNISEX TOILET AND NOT AS PER AMBULANT TOILET]
BACKREST SHALL NOT BE PROVIDED , UNLESS SPECIFICALLY REQUIRED BY THE PARTICIPANT .

Drawing No. Issue Description SDA ASSESSMENT 07.06.2024 9 FRONSAC AVENUE INTERNAL ELEVATIONS - ENS + BATH A402 AA CORIO VIC 3214 Scale Drawing Size 1:50 А3 Project No. Drawn 240501 -₽ys Dimensioned drawings to take precedence over scaling. Contractor to verify all dimensions on site before construction. All inconsistencies to be reported to the Architect immediately. 0.5 1 1.5 2m CAD 1:50 8/06/2024 6:52:21 PM

LEGEND
PB - PARTICIPANT BASIN
CB - CARER BASIN
PBM - P. BASIN MIXER
PSM - P. SHOWER MIXER
PSH - P. SHOWER HEAD
PWC - PARTICIPANT TOILET
CBM - CARER BASIN MIXER
CSM - CARER SHOWER MIXER
CSH - CARER SHOWER HEAD
CWC - CARER TOILET
TR-S - TOWEL RAIL - SINGLE

- SHOWER CURTAIN - SHOWER TRACK - TOILET ROLL HOLDER - SHOWERSCREEN

- FIXED MIRROR


- TILE FINISH - SPLASHBACK - VINYL FINISH - PAINT FINISH

- VANITY CABINET

SC ST TRH SS FM

TF02 TF03 VF02 PF03

JF01 BT01

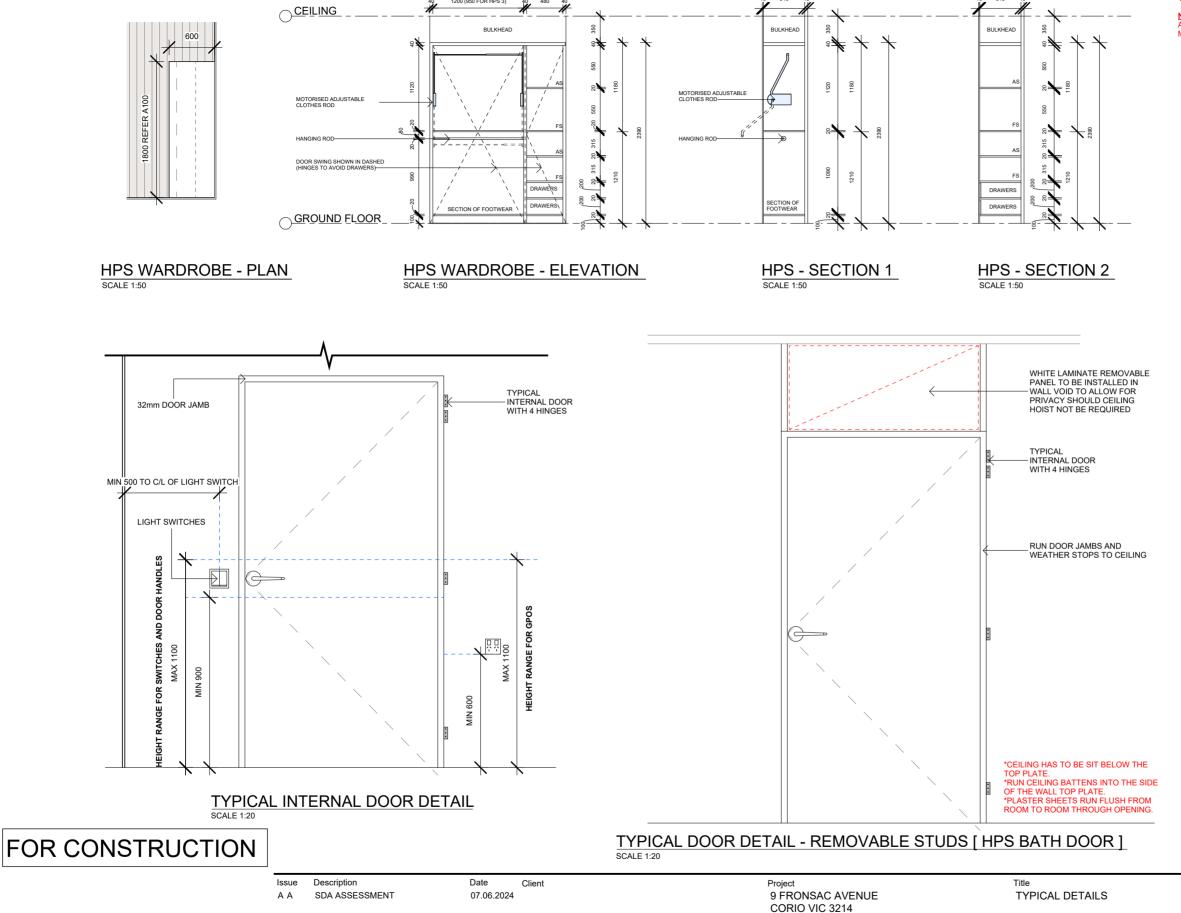

1800 (1550 FOR HPS 3)

NDIS REQUIREMENT
1.DOOR HARDWARE INSTALLED AT BETWEEN 900MM AND 1100MM FROM FFL

NOTE: ALL FILLER PANEL SIZING TO BE THE DISCRETION OF THE JOINERY MANUFACTURERS

Drawing No.

As indicated

8/06/2024 6:52:22 PM

Project No.

240501 -

A500

Scale

CAD

Dimensioned drawings to take precedence over scaling. Contractor to verify all dimensions on site before construction. All inconsistencies to be reported to the Architect immediately.

0.5 1 1.5 2m

1:50

Issue

AA

А3

Drawn

₽¥S

Drawing Size

GENERAL ARCHITECTURAL NOTES

- ALL MATERIALS AND WORK PRACTICES SHALL COMPLY WITH, BUT NOT LIMITED TO THE BUILDING REGULATIONS 2017, THE NATIONAL CONSTRUCTION CODE SERIES 2019 BUILDING CODE OF AUSTRALIA VOLUME 1 AND ALL RELEVANT CURRENT AUSTRALIAN STANDARDS (AS AMENDED) REFERRED TO THEREIN
- LINLESS OTHERWISE SPECIFIED. THE TERM BCA SHALL REFER TO NATIONAL CONSTRUCTION CODE SERIES 2019 BUILDING CODE OF AUSTRALIA VOLUME 1
- ALL MATERIALS AND CONSTRUCTION PRACTICE SHALL MEET THE PERFORMANCE REQUIREMENTS OF THE BUILDING CODE OF AUSTRALIA WHERE A PERFORMANCE SOLUTION IS PROPOSED THEN, PRIOR TO IMPLEMENTATION OR INSTALLATION, IT FIRST MUST BE ASSESSED AND APPROVED BY THE RELEVANT BUILDING SURVEYOR AS MEETING THE PERFORMANCE REQUIREMENTS OF THE BUILDING CODE OF
- GLAZING, INCLUDING LAMINATED SAFETY GLAZING, SHALL BE INSTALLED TO A SIZE, TYPE AND THICKENSS SO AS TO COMPLY WITH:
- AS1288-2006 AND AS2047-1999
- TO MEET SAFETY REQUIREMENTS FOR DISABILITY HOUSING
- WATERPROOFING OF WET AREAS, BEING BATHROOMS, SHOWERS, SHOWER ROOMS, LAUNDRIES, SANITARY COMPARTMENTS AND THE LIKE SHALL BE PROVIDED IN ACCORDANCE WITH AS $3740\hbox{-}2010\hbox{:}$

WATERPROOFING OF DOMESTIC WET AREAS.

THESE DRAWINGS SHALL BE READ IN CONJUNCTION WITH ANY HOUSE ENERGY RATING (HERS) REPORT AND SHALL BE CONSTRUCTED IN ACCORDANCE WITH THE STAMPED PLANS ENDORSED BY THE ACCREDITED THERMAL PERFORMANCE ASSESSOR WITHOUT ALERATION.

- STEP SIZES (OTHER THAN FOR SPIRAL STAIRS) TO BE
- RISERS (R) 190mm MAXIMUM AND 115mm MINIMUM GOING (G) 355mm MAXIMUM AND 240mm MINIMUM
- 2R + 1G = 700mm MAXIMUM AND 550mm MINIMUM
- CONSTRUCTED WITH A LESS THAN 125mm GAP TO OPEN TREADS
- ALL TREADS, LANDINGS AND THE LIKE TO HAVE A SLIP-RESISTANCE CLASSIFICATION OF P3 OR R10 FOR DRY SURFACE CONDITIONS AND P4 OR R11 FOR WET SURFACE CONDITIONS OR A NOSING STRIP WITH A SUP-RESISTANCE CLASSIFICATION OF P3 FOR DRY SURFACE CONDITIONS AND P4 FOR WET SURFACE CONDITIONS.
- PROVIDE BARRIERS WHERE CHANGE IN LEVEL EXCEEDS 1000mm ABOVE THE SURFACE BENEATH LANDSINGS, RAMPS AND/ OR TREADS. BARRIERS (OTHER THAN TENSIONED WIRE BARRIERS) TO BE
- 1000mm MINIMUM ABOVE FINISHED SURFACE LEVEL OR
- BALCONIES, LANDINGS OR THE LIKE, AND
- 865mm MINIMUM ABOVE FINISHED SURFACE LEVEL OF STAIR NOSING OR RAMP, AND
- NOSING OR RAIMF, AND
 VERTICAL WITH A LESS THAN 125mm GAP BETWEEN, AND
 ANY HORIZONTAL ELEMENT WITHIN THE BARRIER BETWEEN
 150mm AND 760mm ABOVE THE FLOOR MUST NOT FACILITATE
- CLIMBING WHERE CHANGES IN LEVEL EXCEEDS 4000mm
 ABOVE THE SURFACE BENEATH LANDINGS, RAMPS AND/ OR TREADS. WIRE BARRIER CONSTUCTION TO COMPLY WITH NCC 2016 BCA PART3.9.2.3 FOR CLASS 1 AND 10 BUILDINGS AND NCC 2016 BCA VOLUME 1. PART D2.16 FOR OTHER CLASSES OF BUILDINGS.
- TOP OF HAND RAILS TO BE MINIMUM 865mm VERTICALLY ABOVE STAIR NOSING AND FLOOR SURFACE OF RAMPS.
- WINDOW SIZES NOMINATED ARE NOMINAL ONLY ACTUAL SIZE MAY VARY ACCORDING TO MANUFACTURER. WINDOWS TO BE FLASHED ALL AROUND. BUILDER TO CONFIRM WINDOW SIZES ON SITE AND WINDOWS ORDERED SHOULD BE TO A STANDARD SIZE AS CLOSE TO THE

WHERE THE BUILDING IS LOCATED IN A TERMITE PRONE AREA, TERMITE PROTECTION TO BE IN ACCORDANCE WITH BCA PART 3.1.3 AND AS3660

NDIS SPECIALIST DISABILITY ACCOMODATION DESIGN STANDARDS EDITION 1.1

CONTRACTER TO ENSURE CONSTRUCTION WILL COMPLY WITH THE NOIS SDA DESIGN STANDARDS AND DOCUMENTATION REVIEWED AND APPROVED BY THE INDEPENDENT SDA ASSESSMENT COMPLETED BY 3D ACCESS.

INSULATION

REFER TO ENERGY RATING REPORT REQUIREMENTS

MASONRY

MASONRY TO BE IN ACCORDANCE WITH AS3700 AJ: DENOTES BRICK ARTICULATION JOINTS. BUILDER IS TO PROVIDE BRICK ARTICULATION JOINTS LOCATED IN COMPLIANCE WITH RECOMMENDATIONS IN GEOTECHNICAL SITE INVESTIGATION REPORT AS PER DRAWING & AT MAX CENTERS. ARTICULATION JOINTS TO EXTERNAL WALLS ARE REQUIRED TO BE SEALED ACHIEVING FIRE RATINGS OF 60 MINUTES WHERE SETBACK IS LESS THAN 3 METRES

ROOF CLADDING

ROOF CLADDING TO BE ACCORDANCE WITH AS1562.1 2018

ROOF PLUMBING

GUTTERS AND DOWNPIPES TO BE ACCORDANCE WITH AS3500

SMOKE DETECTORS

PROVIDE SMOKE DETECTORS IN ACCORDANCE WITH THE NCC 2016 AND A.S.3786 SMOKE DETECTORS TO BE INTERCONNECTED AND CONNECTED TO MAINS POWER

-BUILDING IN MARINE OR OTHER EXPOSURE ENVIRONMENTS SHALL HAVE MASONRY UNITS, MORTAR AND ALL BUILT IN COMPONENTS AND THE LIKE COMPLYING WITH THE DURABILITY REQUIREMENTS OF AS3700-2011 MASONRY STRUCTURES.

- ALL STORM WATER TO BE TAKEN TO THE LEGAL POINT OF DISCHARGE TO THE RELEVANT AUTHORITIES' APPROVAL
- -THESE DRAWINGS SHALL BE READ IN CONJUNCTION WITH ALL RELEVANT STRUCTURAL AND ALL OTHER CONSULTANTS' DRAWINGS/ DETAILS AND WITH ANY OTHER WRITTEN INSTRUCTIONS ISSUED IN THE COURSE OF THE CONTRACT.
- SITE PLAN MEASUREMENTS IN METRES ALL MEASUREMENTS IN MILLIMETRES LINLESS NOTED OTHERWISE
- FIGURED DIMENSIONS TAKE PRECEDENCE OVER SCALED
- THE BUILDER SHALL TAKE ALL STEPS NECESSARY TO ENSURE THE STABILITY AND GENERAL WATER TIGHTNESS OF ALL NEW AND/ OR EXISTING STRUCTURES DURING
- THE BUILDER AND SUBCONTRACTORS SHALL CHECK AND VERIFY ALL DIMENTIONS, SETBACKS, LEVELS AND SPECIFICATIONS AND ALL OTHER RELEVANT DOCUMENTATION PRIOR TO THE COMMENCEMENT OF ANY WORKS. REPORT ALL DISCREPANCIES TO THIS OFFICE FOR CLARIFICATION.
- INSTALLATION OF ALL SERVICES SHALL COMPLY WITH THE RESPECTIVE SUPPLY AUTHORITY REQUIREMENTS
- THE BUILDER AND SUBCONTRACTOR SHALL ENSURE THAT ALL STORM WATER DRAINS. SEWER PIPES AND THE LIKE ARE LOCATED AT SUFFICIENT DISTANCE FROM ANY BUILDING FOOTING AND/OR SLAB EDGE BEAMS SO AS TO PREVENT GENERAL MOISTURE PENETRATION, DAMPNESS, WEAKENING AND UNDERMINING OF ANY BUILDING AND ITS FOOTING SYSTEM.
- A BUILDING PERMIT IS REQUIRED PRIOR TO COMMENCEMENT OF THESE WORKS
- THE APPROVAL BY THIS OFFICE OF A SUBSTITUTE MATERIAL, WORK PRACTISE VARIATION OR THE LIKE IS NOT AN AUTHORISATION FOR ITS USE OR A CONTRACT VARIATION. ALL VARIATIONS MUST BE ACCEPTED BY ALL PARTIES TO THE AGREEMENT AND WHERE APPLICABLE THE RELEVANT BUILDING SURVEYOR PRIOR TO

ENERGY FEFICIENCY:

ALL NEW WORK FOR THE PROJECT SHALL COMPLY WITH THE THERMAL ASSESSMENT AS PREPARED BY THE ENERGY RATER

FIRE SAFETY COMPLIANCE:

THE PROPOSED DEVELOPMENT IS TO COMPLY AS FOLLOWS:

CONSTRUCTION GENERALLY - IN ACCORDANCE WITH BCA PART B1.4: MATERIALS AND FORMS OF CONSTRUCTION; SPECIFICATION C1.1: FIRE-RESISTING CONSTRUCTION FOR TYPE A? CONSTRUCTION) AND SPECIFICATION C1.11: PERFORMANCE OF

EMERGENCY LIGHTING - IN ACCORDANCE WITH BCA PART E4.2 AND E4.4 AND AS 2293.1: EMERGENCY ESCAPE LIGHTING & EXIT SIGNS FOR BUILDINGS.

EXIT SIGNS - IN ACCORDANCE WITH BCA PART E4.5, E4.6, E4.8 AND AS 2293.1: EMERGENCY ESCAPE LIGHTING & EXIT SIGNS FOR BUILDINGS.

FIRE DOORS - IN ACCORDANCE WITH BCA SPECIFICATION C3.4 AND AS 1905.1: COMPONENTS FOR THE PROTECTION OF OPENINGS IN FIRE-RESISTANT WALLS-FIRE

FIRE HYDRANT SYSTEMS - IN ACCORDANCE WITH BCA PART E1.3 AND AS 2419.1: FIRE HYDRANT INSTALLATIONS- SYSTEM DESIGN, INSTALLATION & COMMISSIONING.

FIRE HOSE REEL SYSTEMS - IN ACCORDANCE WITH BCA PART E1.4 AND AS 2441: INSTALLATION OF FIRE HOSE REELS.

PORTABLE FIRE EXTINGUISHERS - IN ACCORDANCE WITH BCA PART E1.6 AND AS 2444: PORTABLE FIRE EXTINGUISHERS AND FIRE BLANKETS - SELECTION AND LOCATION

SMOKE AND HEAT VENTS - IN ACCORDANCE WITH BCA PART E2.2C AND AS 2665: SMOKE/HEAT VENTING SYSTEM - DESIGN, INSTALLATION AND COMMISSIONING

SMOKE DETECTION ALARM AND EXHAUST SYSTEMS - IN ACCORDANCE WITH BCA SPECIFICATION E2.2 AND AS 1670.1: FIRE DETECTION, WARNING, CONTROL AND INTERCOM SYSTEMS, SYSTEM DESIGN, INSTALLATION AND COMMISSIONING- FIRE

SPRINKLERS - IN ACCORDANCE WITH BCA PART E1.5 & SPECIFICATION E1.5. AS 2118: AUTOMATIC FIRE SPRINKLER SYSTEMS. PIPEWORK AND FITTINGS SUPPORTED BY HANGERS, BRACKETS AND/OR GUIDES IN ACCORDANCE WITH AS 4118.2.1: FIRE SPRINKLER SYSTEMS: PIPING- GENERAL

ALL MATERIALS, LININGS, SURFACE FINISHES, FITTINGS AND FIXTURES MUST COMPLY WITH BCA SPECIFICATION C1.10: FIRE HAZARD PROPERTIES

ALL LIGHT SWITCHES TO BE POSITIONED BETWEEN 900mm - 1000mm ABOVE FFL, AND HORIZONTALLY ALIGNED WITH THE DOOR HANDLE AT THE ENTRANCE TO A

ALL LIGHT AND GPO SWITCHES SHALL BE ROCKER ACTION TOGGLE OR PLISH PAD IN

DIMMABLE LIGHTING SWITCHES TO BE PROVIDED IN LIVING AREAS AND BEDROOMS

ARTIFICIAL LIGHTING TO COMPLY WITH AS1680

ENTRANCES AND DOOR HARDWARE:

ALL ENTRANCES, CORRIDORS AND DOOR HARDWARE SHALL COMPLY WITH THE NDIS DESIGN STANDARDS EDITON 1.1 OCTOBER 2019.

PATHS OF TRAVEL & EGRESS:

ALL PATHS AND ACCESSWAYS SHALL BE CONSTRUCTED TO COMPLY WITH THE NDIS DESIGN STANDARDS EDITON 1.1 OCTOBER 2019

ALL MEANS OF EGRESS ARE TO COMPLY WITH BCA PART D1: PROVISION FOR

ALL PATHS OF TRAVEL TO BE 1050MM MIN. CLEAR UNOBSTRUCTED WIDTH FOR COMPLIANCE PLUS TOLERANCE, OR AS PERMITTED BY AN APPROVED ALTERNATIVE

DOORS LOCATED IN PATHS OF TRAVEL TO EXITS TO COMPLY WITH BCA VOL 1 SECTION D2.21: OPERATION OF LATCH AND TO BE OPENABLE AT ALL TIMES WITHOUT THE USE OF A KEY FROM THE SIDE THAT FACES A PERSON SEEKING EGRESS, BY A SINGLE DOWNWARD HAND ACTION LOCATED ON A SINGLE DEVICE BETWEEN 900MM AND 1100MM FROM THE FLOOR.

STAIRS, HANDRAILS AND BALUSTRADES ARE TO COMPLY WITH BCA SECTIONS D2.12, D2.13, D2.14, D2.15, D2.16 AND D2.17.

EASE OF DOOR OPENING - NON-AUTOMATIC DOORS MUST OPEN MANUALLY UNDER A FORCE OF NOT MORE THAN 110 N

ROOFING MATERIALS

ALL ROOFING TO BE SELECTED, SUPPLIED AND INSTALLED TO PROVIDE A COMPLETE WATERTIGHT AND WEATHERPROOF BUILDING INCORPORATING ALL NECESSARY CAPPINGS, TRIMS, FLASHINGS, SARKING, SEALING AND JOINT MATERIALS. ALL METAL RAINWATER GOODS ARE TO BE SELECTED, SUPPLIED AND INSTALLED IN ACCORDANCE WITH THE AUSTRALIAN STANDARDS

ALL PRACTICES TO BE COMPLIANT WITH ALL RELEVANT AUSTRALIAN STANDARDS, WORKSAFE CODES AND OH&S REGULATIONS INCLUDING BUT NOT LIMITED TO AS 1891.4:2009 INDUSTRIAL FALL ARREST SYSTEMS AND DEVICES; WORKSAFE CODE OF PRACTICE, SAFE WORK ON ROOFS, PART 1, COMMERCIAL AND INDUSTRIAL

ALL METAL RAINWATER GOODS TO BE SELECTED, SUPPLIED AND INSTALLED IN ACCORDANCE WITH AS 2179.1 ROOF CONSTRUCTION. ROOF AND WALL INSULATION IS TO COMPLY WITH BCA VOL. 1 SECTION J REQUIREMENTS. PROVIDE ALL MATERIALS AND ACCESSORIES TO ENSURE COMPLETE WATERTIGHTNE

AREAS AND REFERENCE LEVELS:

AREAS QUOTED ARE APPROXIMATE ONLY. FOR ACCURATE AREA MEASUREMENTS, A LICENSED SURVEYOR MUST BE ENGAGED

ALL LEVELS AND RLS INDICATED RELATE TO THE AUSTRALIAN HEIGHT DATUM (AHD). A BENCHMARK IS TO BE ESTABLISHED ADJACENT TO THE SITE TO AUSTRALIAN HEIGHT DATUM TO ENABLE COMPARISON WITH THE FLOOD STANDARD.

ALL SURVEY INFORMATION AND LEVELS. ARE REFERENCED FROM THE SURVEY PLAN AND ARE TO BE CHECKED ON SITE PRIOR TO CONSTRUCTION AND/OR MANUFACTURING. REPORT ANY DISCREPANCIES TO THE SUPERINTENDENT IMMEDIATELY.

THE FLOOR LEVEL IS TO BE CERTIFIED BY A REGISTERED SURVEYOR PRIOR TO POURING OF FLOOR SLABS OR INSTALLATION OF FLOORING

SETTING OUT:

THE CONTRACTOR IS TO CHECK AND VERIEVALL SETOLIT DIMENSIONS AND LEVELS ON SITE PRIOR TO THE COMMENCEMENT OF ANY RELEVANT PART OF THE WORKS

A LICENSED SURVEYOR IS TO ESTABLISH THE EXACT POSITION OF ALL SET BACKS AND PROPERTY BOUNDARIES PRIOR TO THE COMMENCEMENT OF ANY CONSTRUCTION OR EXCAVATION. BUILDING SETBACKS ARE TO BE SET OUT FROM THE BOUNDARY TO THE FINISHED EXTERNAL FACE OF EXTERNAL WALLS

ALL SET OUT DIMENSIONS AND LEVELS ARE TO BE CHECKED BY THE LICENSED SURVEYOR ON SITE AND ALL OVERALL AND CRITICAL DIMENSIONS ARE TO BE SET OUT FOR SUPERINTENDENT APPROVAL PRIOR TO THE COMMENCEMENT OF ANY CONSTRUCTION OR EXCAVATION.

NO PART OF THE BUILDING IS TO BE CONSTRUCTED OVER A SPECIFIED SETBACK LINE, EASEMENT OR PROPERTY BOUNDARY EXCEPT WHERE SPECIFICALLY SHOWN ON THE DRAWINGS. REPORT ANY DISCREPANCIES IN THE BUILDING SETOUT TO THE SUPERINTENDENT IMMEDIATELY

THE RELATIVE LEVELS (RL) OF PROPOSED PAVING AND OTHER GROUND FINISHES ARE INDICATIVE ONLY. REFER TO THE CIVIL, STRUCTURAL, HYDRAULIC ENGINEERS' AND LANDSCAPE ARCHITECT'S DRAWINGS FOR ALL HARDSTAND LEVELS, GRADIENTS

SOIL CLASSIFICATION:
THESE PLANS SHALL BE READ IN CONJUNCTION WITH THE SOIL REPORT. FOOTINGS TO BE FOUNDED AT THE MINIMUM DEPTHS INDICATED IN THE SOIL REPORT. THE H.G.F.L. RECOMMENDS THAT THE FOOTINGS/SLABS DRAINAGE TO BE DESIGNED AND INSPECTED BY ANY ENGINEER TO SATISFY THEIR REQUIREMENTS.

SLIP RESISTANCE OF FLOOR SURFACES:

THE DEVELOPMENT IS TO COMPLY WITH THE MINIMUM RECOMMENDATIONS IN THE NDIS DESIGN STANDARDS EDITION 1.1 OCTOBER 2019.

TIMBER FLOOR, WALL AND ROOF FRAMING
ALL WORKS TO BE CARRIED OUT IN STRICT ACCORDANCE WITH THE AS1684 - TIMBER FRAMING CODE AND SUPPLEMENARY TABLES.

SANITARY COMPARTMENTS

DOORS TO SANITARY COMPARTMENTS MUST BE OPENABLE, SLIDE OR BE READILY REMOVABLE FROM OUTSIDE TO COMPARTMENT UNLESS THERE IS A CLEAR PACE OF AT LEAST 1.2M BETWEEN THE CLOSEST PAN WITH THE SANITARY COMPARTMENT AND THE NEAREST PAT OF A DOORWAY.SANITARY COMPARTMENTS TO COMPLY WITH BCA 3 8 3 3

WARRANTIES & CERTIFICATES:

PRIOR TO PRACTICAL COMPLETION THE RELEVANT SUBCONTRACTOR MUST PROVIDE CERTIFICATION THAT THE WORKS HAVE BEEN DESIGNED, SELECTED AND INSTALLED IN ACCORDANCE WITH THE BCA, RELEVANT AUSTRALIAN STANDARDS AND ANY MANUFACTURER'S RECOMMENDATIONS.

PRIOR TO PRACTICAL COMPLETION THE RELEVANT SUBCONTRACTOR MUST PROVIDE COPIES OF ALL MANUFACTURER'S WRITTEN WARRANTIES.

ALL CERTIFICATION REQUIRED FOR OCCUPATION CERTIFICATE TO THE SATISFACTION OF THE CERTIFYING AUTHORITY TO BE SUBMITTED BY PRACTICAL COMPLETION, INCLUDING BUT NOT LIMITED TO: STRUCTURAL CERTIFICATION, MECHANICAL CERTIFICATION, ALARM SIGNALING EQUIPMENT, AUTOMATIC FIRE SUPPRESSION SYSTEM, FIRE DETECTION & ALARM SYSTEM, BUILDING OCCUPANT WARNING SYSTEM, EMERGENCY LIGHTING, EXIT SIGNS, FIRE SEALS, FIRE HOSE REELS, FIRE HYDRANT SYSTEMS, FIRE DOORS, SMOKE DOORS, PATHS OF TRAVEL, PORTABLE FIRE EXTINGUISHERS, ELECTRICAL CERTIFICATION, PLUMBING CERTIFICATION, GLAZING CERTIFICATION, LIFT AND LIFT SHAFT CERTIFICATION, BALUSTRADE CERTIFICATION AS APPLICABLE TO THE PROJECT.

SEISMIC CONSIDERATIONS ARE TO BE ADOPTED AS APPROPRIATE INCLUDING NON-STRUCTURAL PARTS AND SERVICES COMPONENTS AS SPECIFIED IN SECTION 8 OF AS 1170.4

FOR CONSTRUCTION

Issue Description SDA ASSESSMENT

Client 07.06.2024

9 FRONSAC AVENUE CORIO VIC 3214

GENERAL NOTES

Drawing No. Issue A600 AA Scale Drawing Size A3 Project No. Drawn 240501 -₽ys CAD

Dimensioned drawings to take precedence over scaling. Contractor to verify all dimensions on site before construction. All inconsistencies to be reported to the Architect immediately.

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